

DO NOT SCALE FROM THIS DRAWING. USE FIGURED DIMENSIONS IN ALL CASES. VERIFY DIMENSIONS ON SITE AND REPORT ANY DISCREPANCIES TO THE DESIGNERS IMMEDIATELY.
THIS DRAWING TO BE READ IN CONJUNCTION WITH THE DESIGNERS SPECIFICATION
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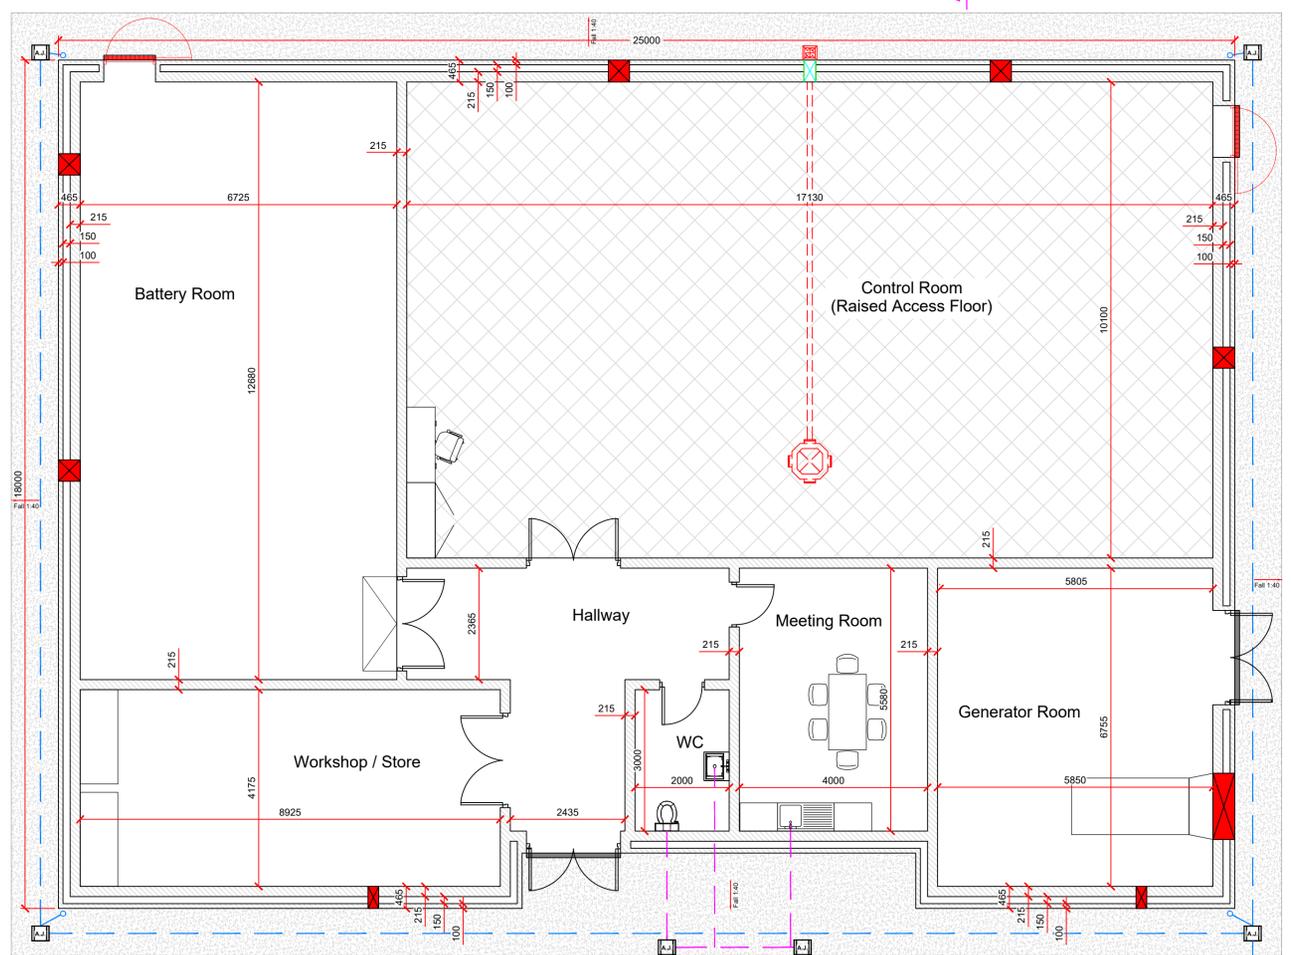
- NOTES:
1. ALL DRAWINGS ARE TO BE READ IN CONJUNCTION WITH ALL RELEVANT SPECIFICATIONS, BILLS OF QUANTITIES, ARCHITECTURAL, SERVICES AND ENGINEERING DRAWINGS.
 2. ALL LEVELS ARE IN METRES RELATED TO ORDNANCE DATUM MALIN HEAD.
 3. ANY DISCREPANCIES BETWEEN THESE DOCUMENTS SHALL BE BROUGHT TO THE ATTENTION OF THE ENGINEER.
 4. DRAWINGS ARE NOT TO BE SCALED.
 5. ALL DIMENSIONS ARE IN MILLIMETRES, UNLESS NOTED OTHERWISE.
 6. THE FINALISED LAYOUT MAY BE SUBJECT TO MICRO-SITING DUE TO UNFORESEEN GROUND CONDITIONS. THE EXTENT OF FLEXIBILITY WILL BE SITE SPECIFIC AND SHOULD GENERALLY NOT EXTEND BEYOND 20 METRES.

REFERENCE DRAWINGS:


DRAWING No.	Description
19876-MWP-00-00-DR-C-5005	Proposed Site Layout - Master Sheet
19876-MWP-00-00-DR-C-5409	Proposed Substation Compound Layout

LEGEND


	Concrete Footpath (Impermeable)
	100mm Ø uPVC Foul Water Pipe
	100mm Ø uPVC Storm Water Pipe
	Foul Water AJ
	Foul Water Manhole
	Storm Water AJ
	Storm Water Manhole




Plan Scale 1:75

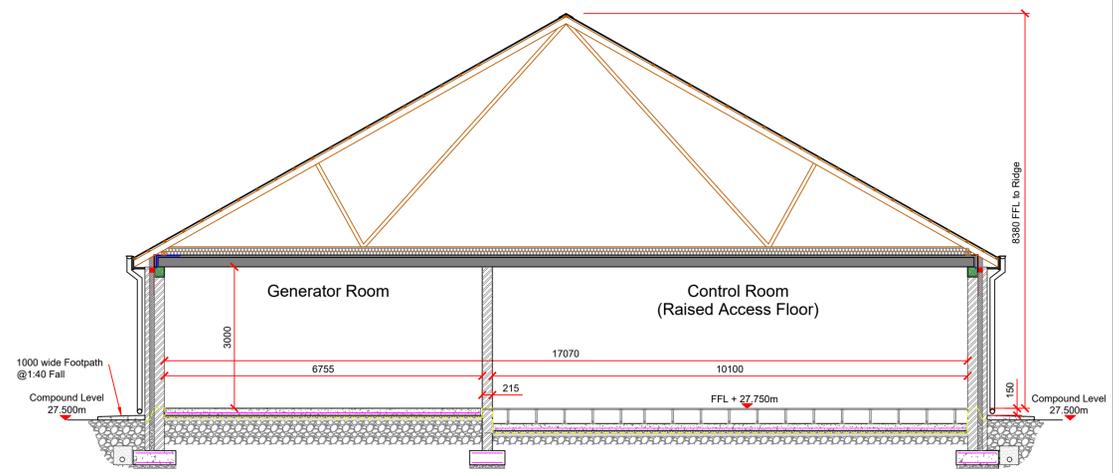


Section A-A Scale 1:75

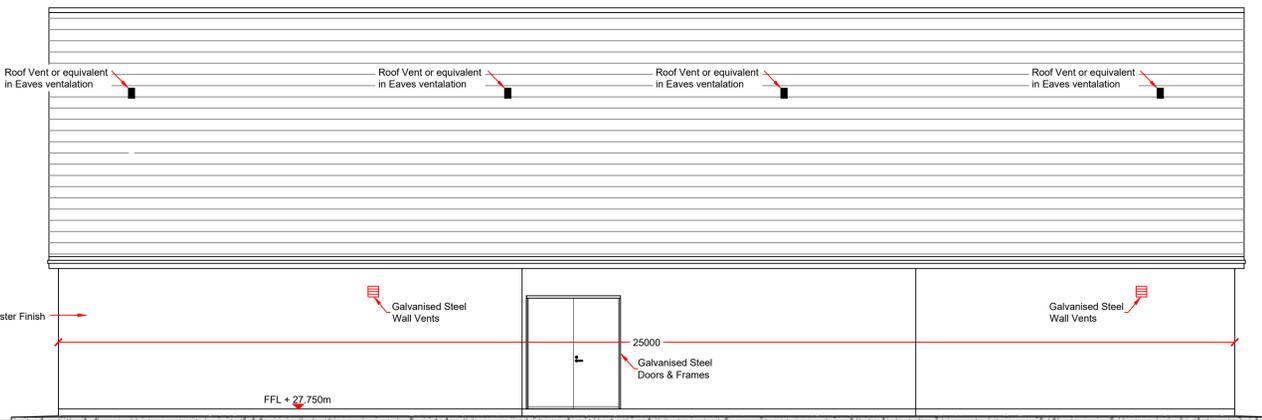


Front Elevation - Northwest Scale 1:75

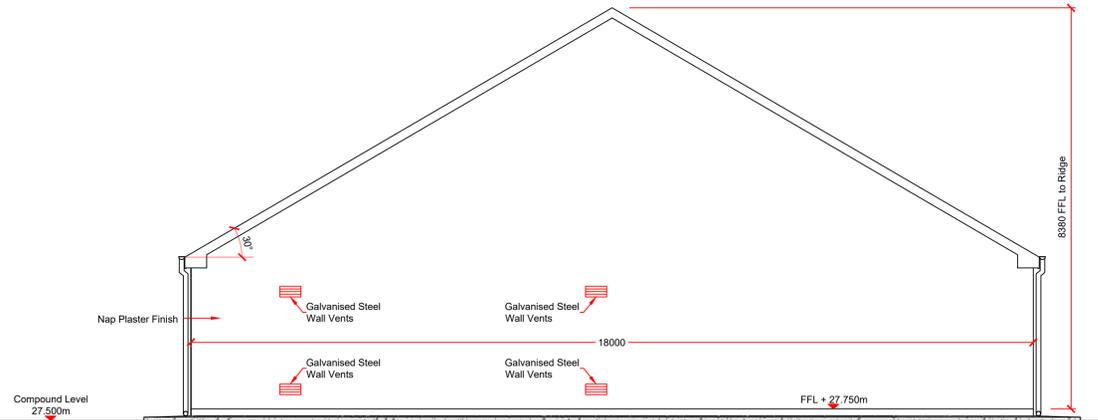

Side Elevation - Northeast Scale 1:75

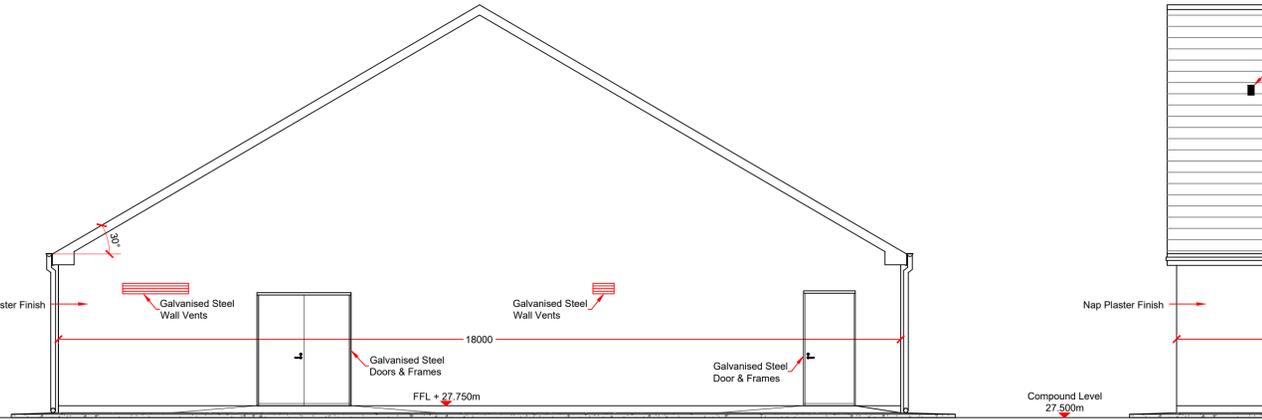

Side Elevation - Southwest Scale 1:75

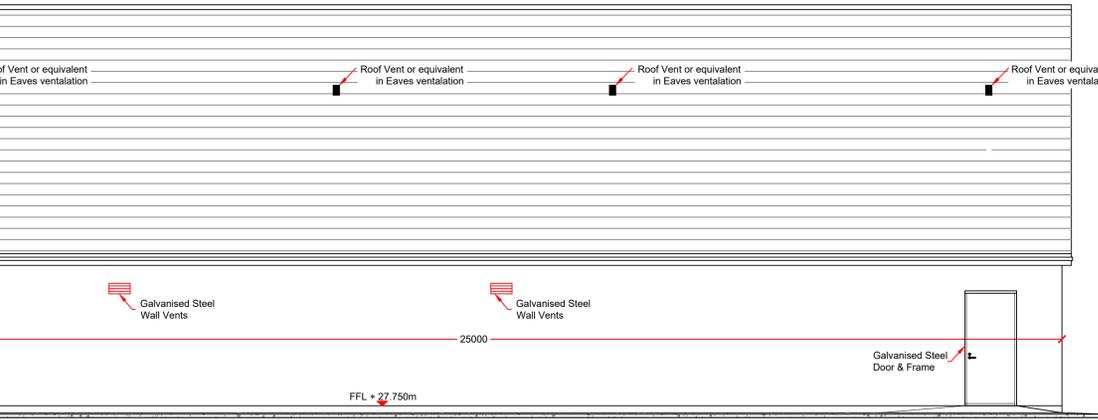

Rear Elevation - Southeast Scale 1:75

P01	14/01/2021	Issued For Planning		JK	KF
REV	DATE	DESCRIPTION		BY	APP

PROJECT: Shronowen Wind Farm

TITLE: EirGrid Substation Building - Plan, Elevations and Section

CLIENT: Shronowen Wind Farm Limited

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DRAWN: JK	CHECKED: PC	APPROVED: PC
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DATE: September 2020	SCALE @ A1: As Shown
PROJECT NUMBER: 19876	DRAWING STATUS: S2

DRAWING NUMBER: 19876-MWP-00-00-DR-C-5412 REV: P01